

CAMBS GLASS LTD TEL -UNIT 3 SWAN LANE FAX -**EXNING** 

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NEWMARKET E-MAIL info@cambsglass.co.uk CB8 7EN WEBSITE -

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### SPECIFICATION

### GLASS SPECIFICATION

6mm CLEAR TOUGHENED LOW E 16mm BLACK SILICONE SEALED SPACER 6mm CLEAR TOUGHENED OUTER

ALL GLASS CONFORMING TO IMPACT RESISTANCE AND BREAKAGE CHARACTERISTICS OF BS6206, WITH ALL GLASS UNITS FABRICATED TO BS5713A AND IN ACCORDANCE WITH BS6262

### FINISH SPECIFICATION

POLYESTER POWER COATED TO ANY STANDARD RAL REFERANCE

POLYESTER POWER COATING, MINIMUM THICKNESS OF 40 MICRONS.

## FRAMEWORK SPECIFICATION

ALL ALUMINIUM EXTRUSIONS TO COMPLY WITH BS1474 AND ALUMINIUM SHEET/PLATE TO BS EN 485, 515 & 573. TYPICALLY PROVIDED IN GRADES 1983 & 6082 (EXTRUSIONS) AND S1CH4 & N54 (SHEET/PLATE). ALL MILD STEEL ZOMPONENTS TO BE GALVANISED, ZINC COATED OR RED OXIDE PRIMED 'RIOR TO FINISH APPLICATION. ALL STAINLESS STEEL COMPONENTS 'ROVIDED IN GRADE 304 STAINLESS STEEL UNLESS OTHERWISE NOTED. XTREME ENVIRONMENTS (INC. MARINE) MUST BE HIGHLIGHTED AT SALES IR DESIGN STAGE.

## HARDWARE SPECIFICATION

ALL HARDWARE TO BE SCHEDULED FOR PURPOSE, TAKING INTO CONSIDERATION BOTH ENVIRONMENT AND BIMETALLIC REACTIONS. FASTENERS TYPICALLY SUPPLIED IN GRADE A2 & A4 STAINLESS STEEL. ALL GASKETS AND TAPES TO HAVE A COMPOSITION SUITABLE FOR CLIMATIC CONDITIONS AND UV LIGHT IN ACCORDANCE WITH BS4255, SILICONES TO BE SUPPLIED AS LOW MODULUS, NEUTRAL CURE (TYPE A) IN ACCORDANCE WITH BS5889 UNLESS OTHERWISE NOTED.

## UPSTAND/APERURE SPECIFICATION

ALL UPSTANDS/APERTURES TO BE PROVIDED WITHIN A TOLERANCE OF +/DWM TO THE DIMENSIONS STATED (TAKING INTO CONSIDERATION THE
QUARENESS OF THE STRUCTURE). ANY DIFFERING TOLERANCE
EQUIREMENTS AS INDICATED. ALL UPSTANDS/APERTURES TO BE SUITABLE
OR SEALING WHERE INDICATED AND STRUCTURALLY ADEQUATE FOR THE
DADS IMPOSED.


### CLIENT

# CONTRACT SALES DETAIL

JOB REF SD	<del>•</del> =
ISSUE A NEW DRAWING ISSUE	NAME AME DATE 30/04/15
ISSUE B	NAME DATE
ISSUE C	NAME DATE
ISSUE D	NAME DATE

PLAN AND ELEVATIONS OF 1 NO ROOFLIGHT WITH GLASS FINS

DRG No. SD-MPGF-001 ISS.

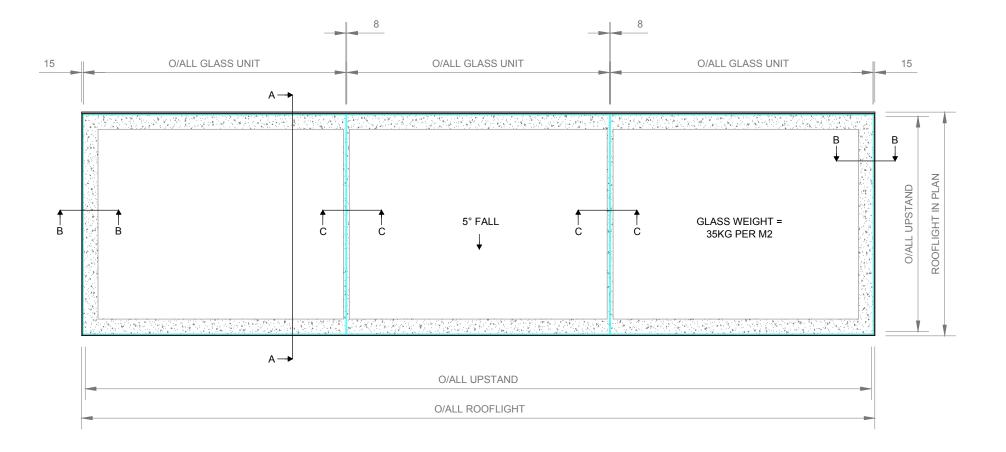


# PLAN VIEW / TRUE VIEW

SCALE NTS (A3)




# FRONT ELEVATION

SCALE NTS (A3)

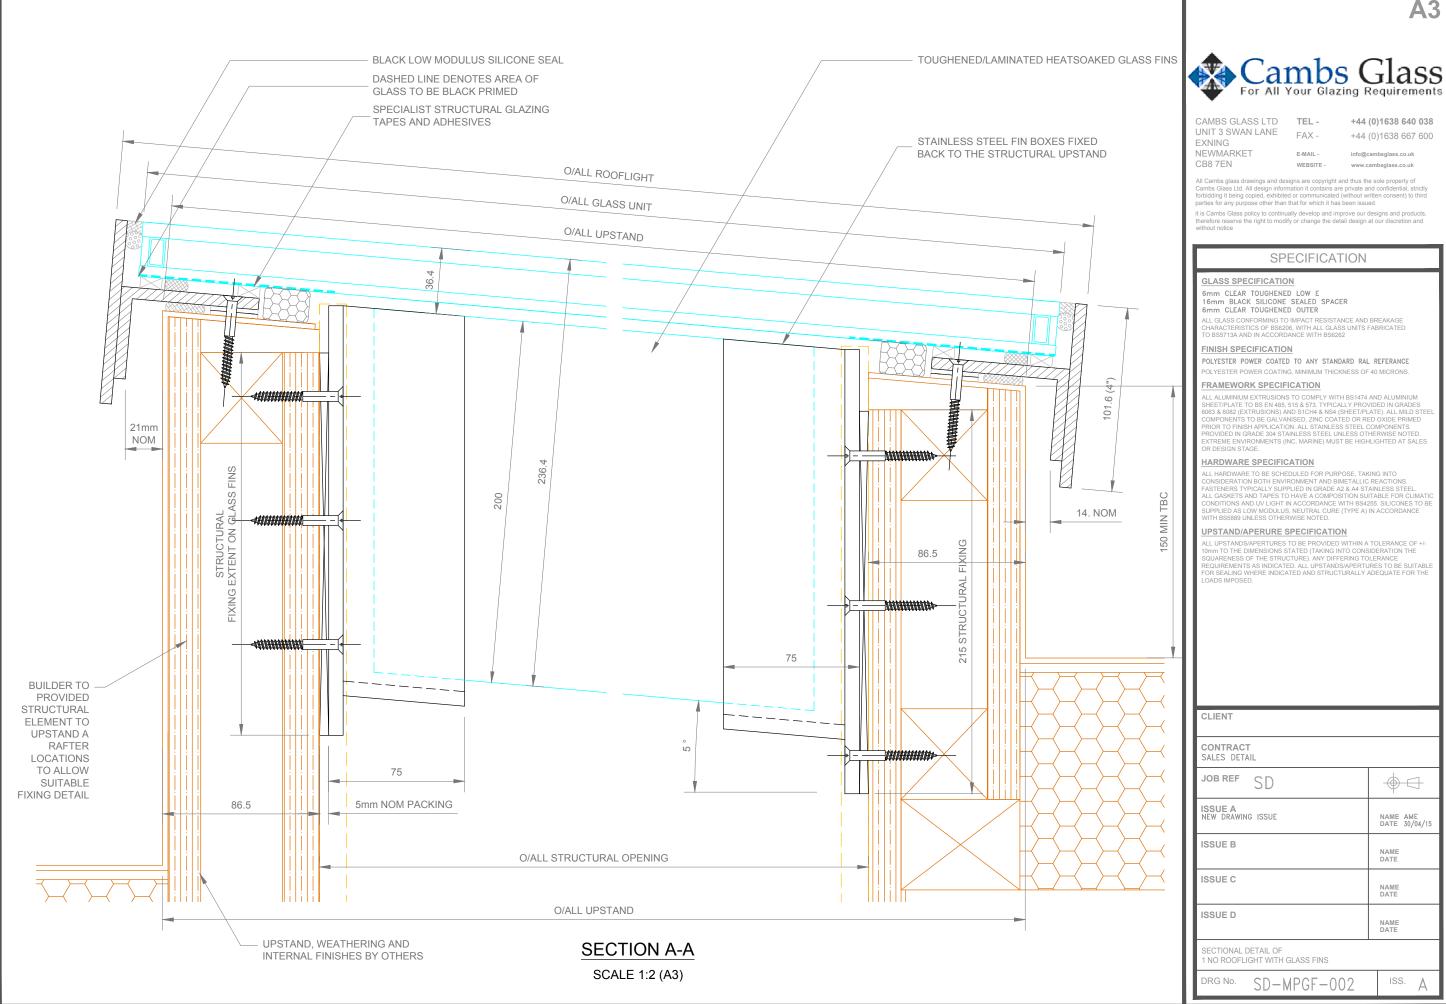

## SECTION B-B SCALE 1:2 (A3)

# SECTION C-C SCALE 1:2 (A3)

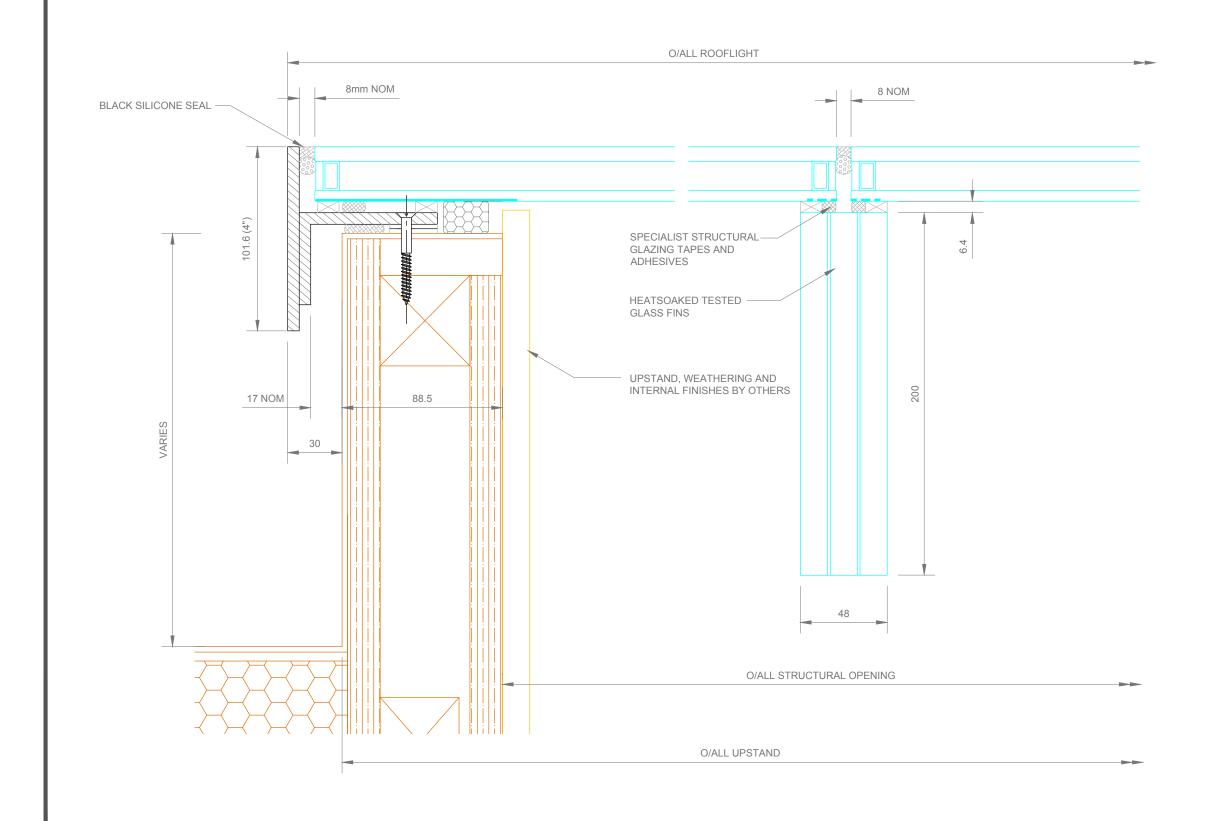



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it is Cambs Glass policy to continually develop and improve our designs and products, therefore reserve the right to modify or change the detail design at our discretion and without notice

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## UPSTAND/APERURE SPECIFICATION

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REQUIREMENTS AS INDICATED. ALL UPSTANDS/APERTURES TO BE SUITABLE
FOR SEALING WHERE INDICATED AND STRUCTURALLY ADEQUATE FOR THE
LOADS IMPOSED.

# 00110401

CLIENT

CONTRACT
SALES DETAIL

JOB REF SD

NAME AME DATE 30/04/15

ISSUE B

ISSUE A NEW DRAWING ISSUE

> NAME DATE

ISSUE D

ISSUE C

SECTIONAL DETAIL OF 1 NO ROOFLIGHT WITH GLASS FINS

DRG No. SD-MPGF-003

ISS.

NAME DATE